


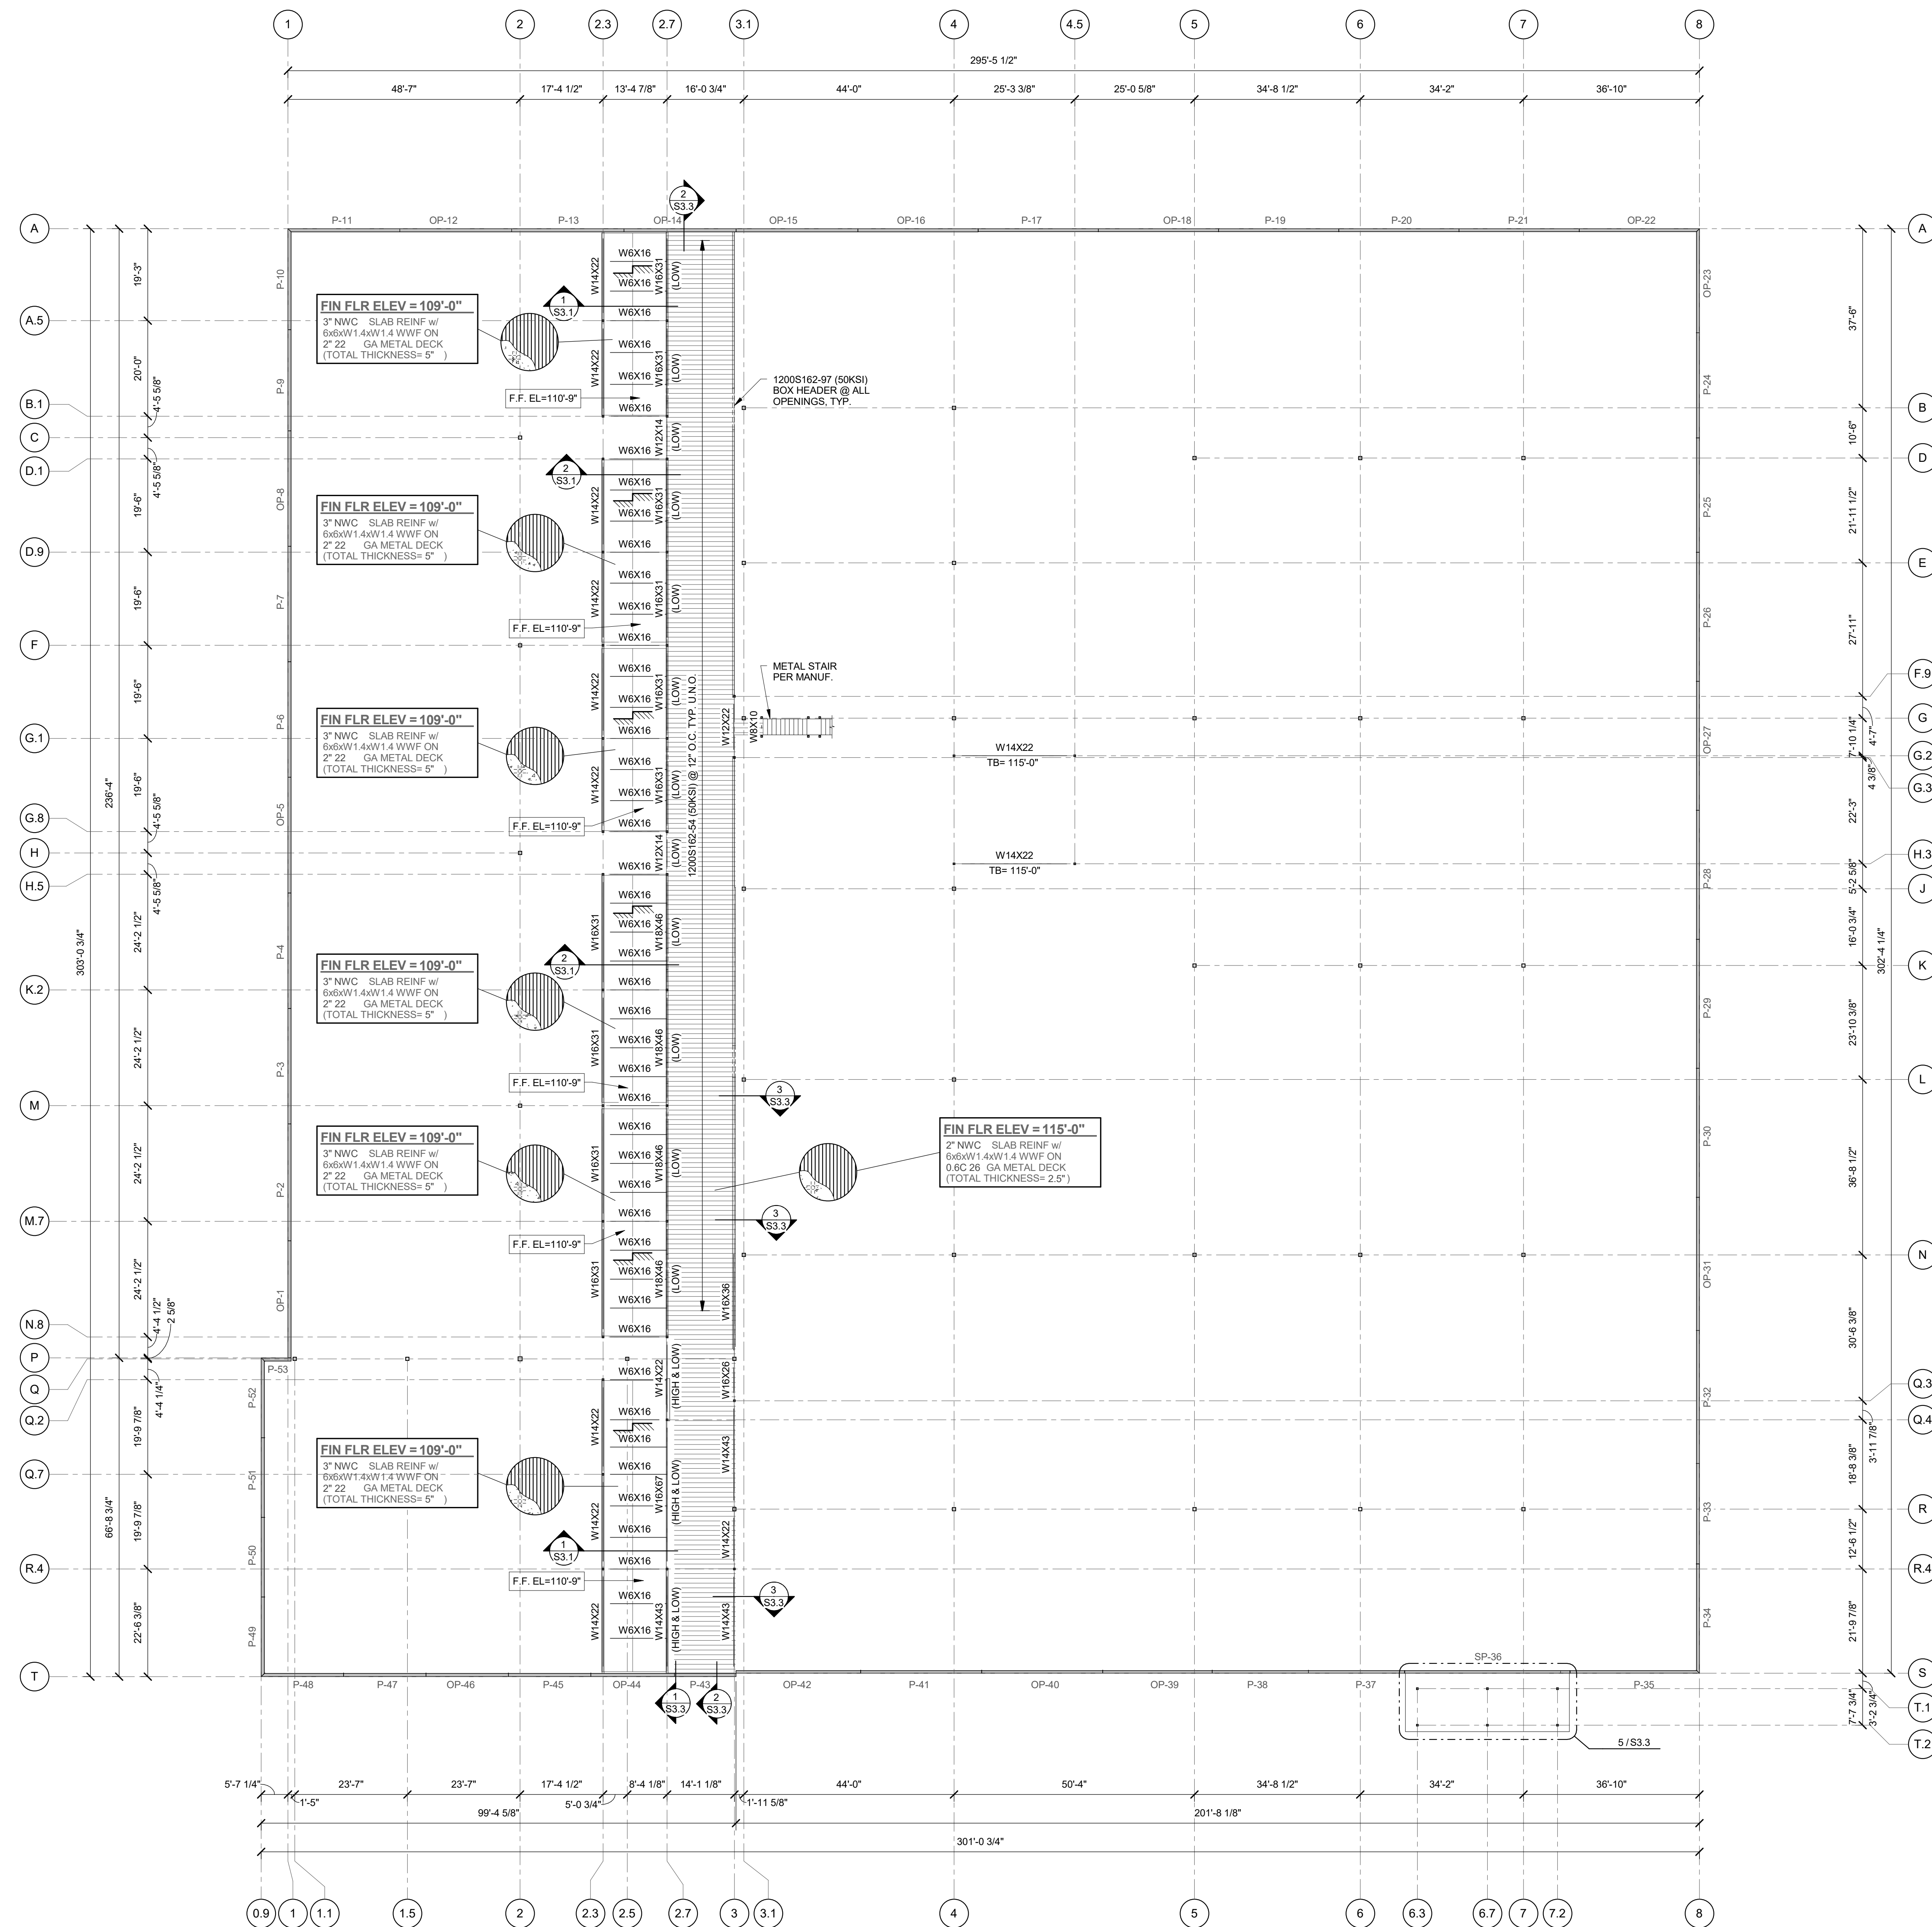

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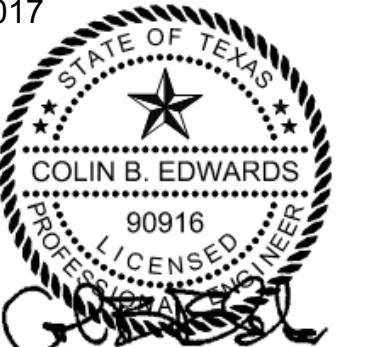


1 Mezzanine Framing Plan
1/16" = 1'-0"



NOTES:
1. ALL ELEVATIONS ARE BASED ON A RELATIVE ELEVATION OF 100'-0" EQUAL TO THE INDICATED DATUM ELEVATION. VERIFY DATUM ELEVATION WITH THE LATEST CIVIL DRAWINGS PRIOR TO CONSTRUCTION.
2. TOP OF BEAM ELEVATION (TB)= XXX'-XX" (TYP UNCL)
3. DETAILING OF ALL MEMBER CONNECTIONS TO THE SUPPORTS SHALL BE PERFORMED TO SATISFY LATEST OSHA ERECTION REQUIREMENTS.
4. NO SHORING REQUIRED DURING COMPOSITE FLOOR CONSTRUCTION.

05-24-2017



PROJECT NO: 10284 TX REG 90263
HUNT & JOINER, INC.
Consulting Structural Engineers

REV.	DATE	ISSUE TITLE
1	05-24-17	ISSUE FOR BID

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CINERAY AMARILLO

MEZZANINE FRAMING PLAN

PROJECT NUMBER S1.2 SHEET NUMBER